
FLOOR PLAN

MAIN LEVEL

2ND LEVEL

ATTIC

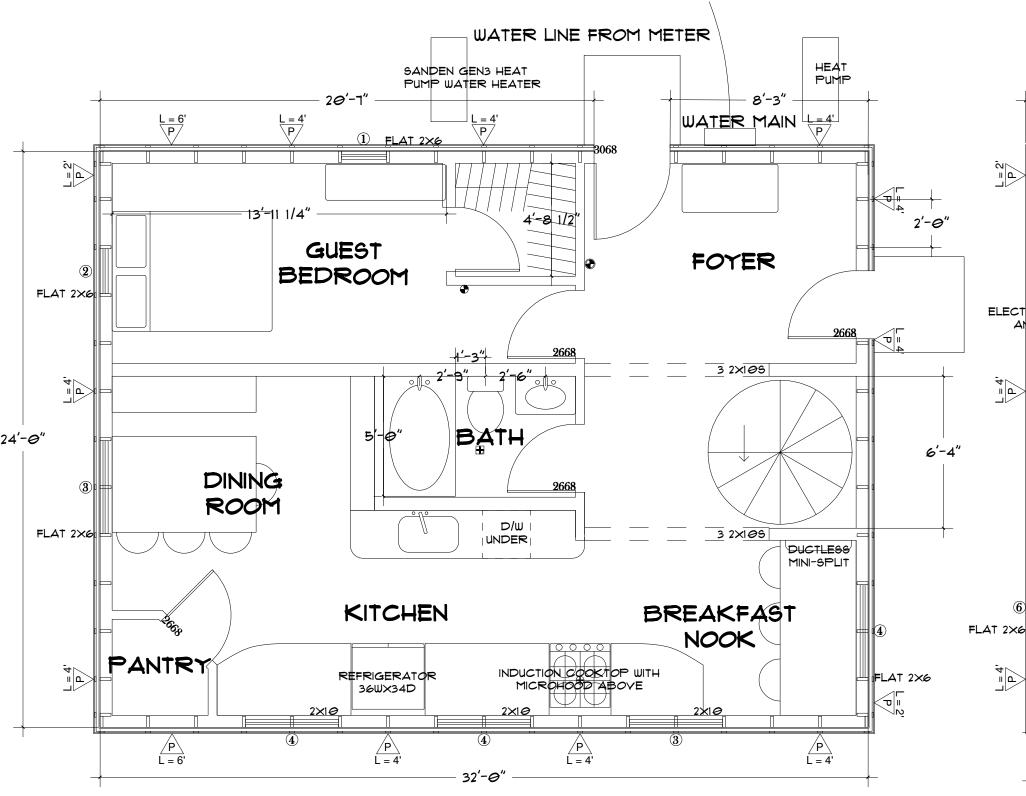

- ◆ SMOKE DETECTOR
- COMBINATION SMOKE/CO DETECTOR
- ⊕ EXHAUST FAN DIRECT VENTED TO EXTERIOR

BETWEEN FLOOR AND

LANDING WITH RUN AT

FROM NARROW EDGE

LEAST 9" MEASURED 12"

EXHAUST FAN DIRECT DUCTED TO HRY

ELECTRIC VENTERS WASHER AND DRIFTER COMBO MASTER BATH MASTER BEDROOM PLAT 2X66 LIVING ROOM APPLIANCES - ALL ELECTRIC NO FOSSIL FUEL BURNING PART AND FOSSIL FUEL BURNING PART AND PART AN

APPLIANCES TO

BE INSTALLED

WALL BRACING

ATTACHED WALK OUT DECK

15/32" APA RATED 24/16 EXPOSURE I SHEATHING WITH 8D COMMON NAILS (0.131"X2.50") @ 6" O.C. ON EDGES AND 12" O.C. IN THE FIELD

HORIZONTAL BRACED PANEL LENGTHS EXTRAPOLATED USING TABLE 602.10.3(3) ADJUSTMENT FACTOR 1.4 FROM TABLE 602.10.3(4) (EXTENDED BWL) VERTICAL PANEL LENGTHS EXTRAPOLATED USING TABLE 602.10(3)

MINIMUM LENGTH OF BRACED WALL PANEL 24" FROM TABLE 602.10.5

STAIR RISE MAX OF 8" WITH A MAX OF 3/8" VARIANCE GUARDRAILS SPACED 90 A 4" SPHERE CANNOT PASS THROUGH GUARDRAIL HEIGHT AT LEAST 40" 13 TREADS

HANDGRIP

PERIMETER


MAX OF 6 1/4"

SPIRAL STAIR DETAIL

WINDOW SCHEDULE

Number	Type	Width	Height	Quantity	Egress	Glazing	Sill Height 36"
1	Single Hung	1'10"	3'8"	1	Yes	No	36"
2	P icture	1'10"	4'0"	1	No	No	36"
3	Single Hung	3'10"	4'0"	2	No	No	36"
4	Picture	3'10"	4'0"	3	No	No	36"
5	Single Hung	1'10"	3'8"	1	Yes	No	146"
6	Picture	1'10"	3'8"	1	No	No	146"
7	Single Hung	3'10"	4'0"	1	No	No	146"
8	Picture	1'10"	4'10"	1	No	No	115"

WINDOW 8 - HORIZONTAL RAIL INSTALLED ON ACCESSIBLE SIDE OF GLAZING AT LEAST 34 INCHES ABOVE WALKING SURFACE AND CAPABLE OF WITHSTANDING HORIZONTAL LOAD OF 50 PLF WITHOUT CONTACTING GLASS

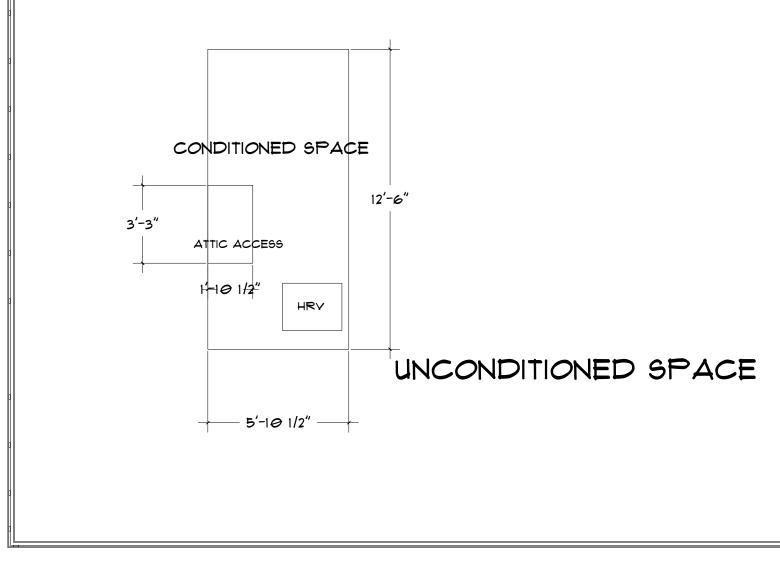

ALL STUDS SHALL BE MINIMUM #2 2X6 DOUGLAS FIR OR BETTER AND SPACED 24" OC

SINGLE TOP PLATE ON ALL EXTERIOR WALLS SPLICED AT CORNERS WITH 3"X8"X0.036" GALYANIZED STEEL PLATE OR EQUIVALENT WITH 9-8D BOX NAILS (2.5"X0.0113") EACH SIDE

EXTERIOR WALL TOP PLATES SHALL BE FULL LENGTH WITH NO STRAIGHT WALL JOINTS

BOTTOM PLATES SHALL BE #2 2X6 PRESSURE TREATED DOUGLAS FIR OR BETTER

1/2" GYPSUM WALL BOARD SHALL BE INSTALLED ON ALL INTERIOR WALLS ON MINIMUM 2X BACKING

DRYWALL SCREWS SHALL BE OF TYPE S OR TYPE W AND SHALL PENETRATE THE WOOD NOT LESS THAN 5/8".

5/16" FIBER CEMENT LAP SIDING SHALL BE FASTENED WITH 5D COOLER NAILS (1 5/8"×0.086") THAT PENETRATE THE 1×4 FURRING STRIPS NOT LESS THAN 1 1/2"

FIBER CEMENT LAP SIDING SHALL HAVE A MAX.
WIDTH OF 12" AND BE LAPPED A MINIMUM OF 1 1/4"



OLMEDO HOME 1554 OCEAN VIEW LN. POINT ROBERTS, WA OCEAN VIEW ESTATES APN# 405310101404

DRAWN BY: M BATH

DATE: 04/22/2017

SCALE: 1/4" = 1'

SHEET

2.0